
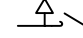
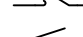
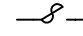
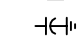
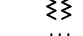
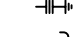
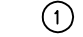








LEGEND

-  MOTOR OPERATED SWITCH
-  LOAD BREAK SWITCH
-  AIR SWITCH
-  DISCONNECT
-  FUSED DISCONNECT
-  CIRCUIT BREAKER
-  CAPACITOR BANK
-  POWER TRANSFORMER
-  CURRENT TRANSFORMER
-  SURGE ARRESTER
-  POTENTIAL TRANSFORMER
-  WIND TURBINE GENERATOR
-  CABLE TERMINATION

NOTE: CONFIGURATION OF WIND FARM COLLECTOR SYSTEM SUBJECT TO CHANGE DEPENDING UPON DETAILED ENGINEERING DESIGN.

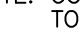

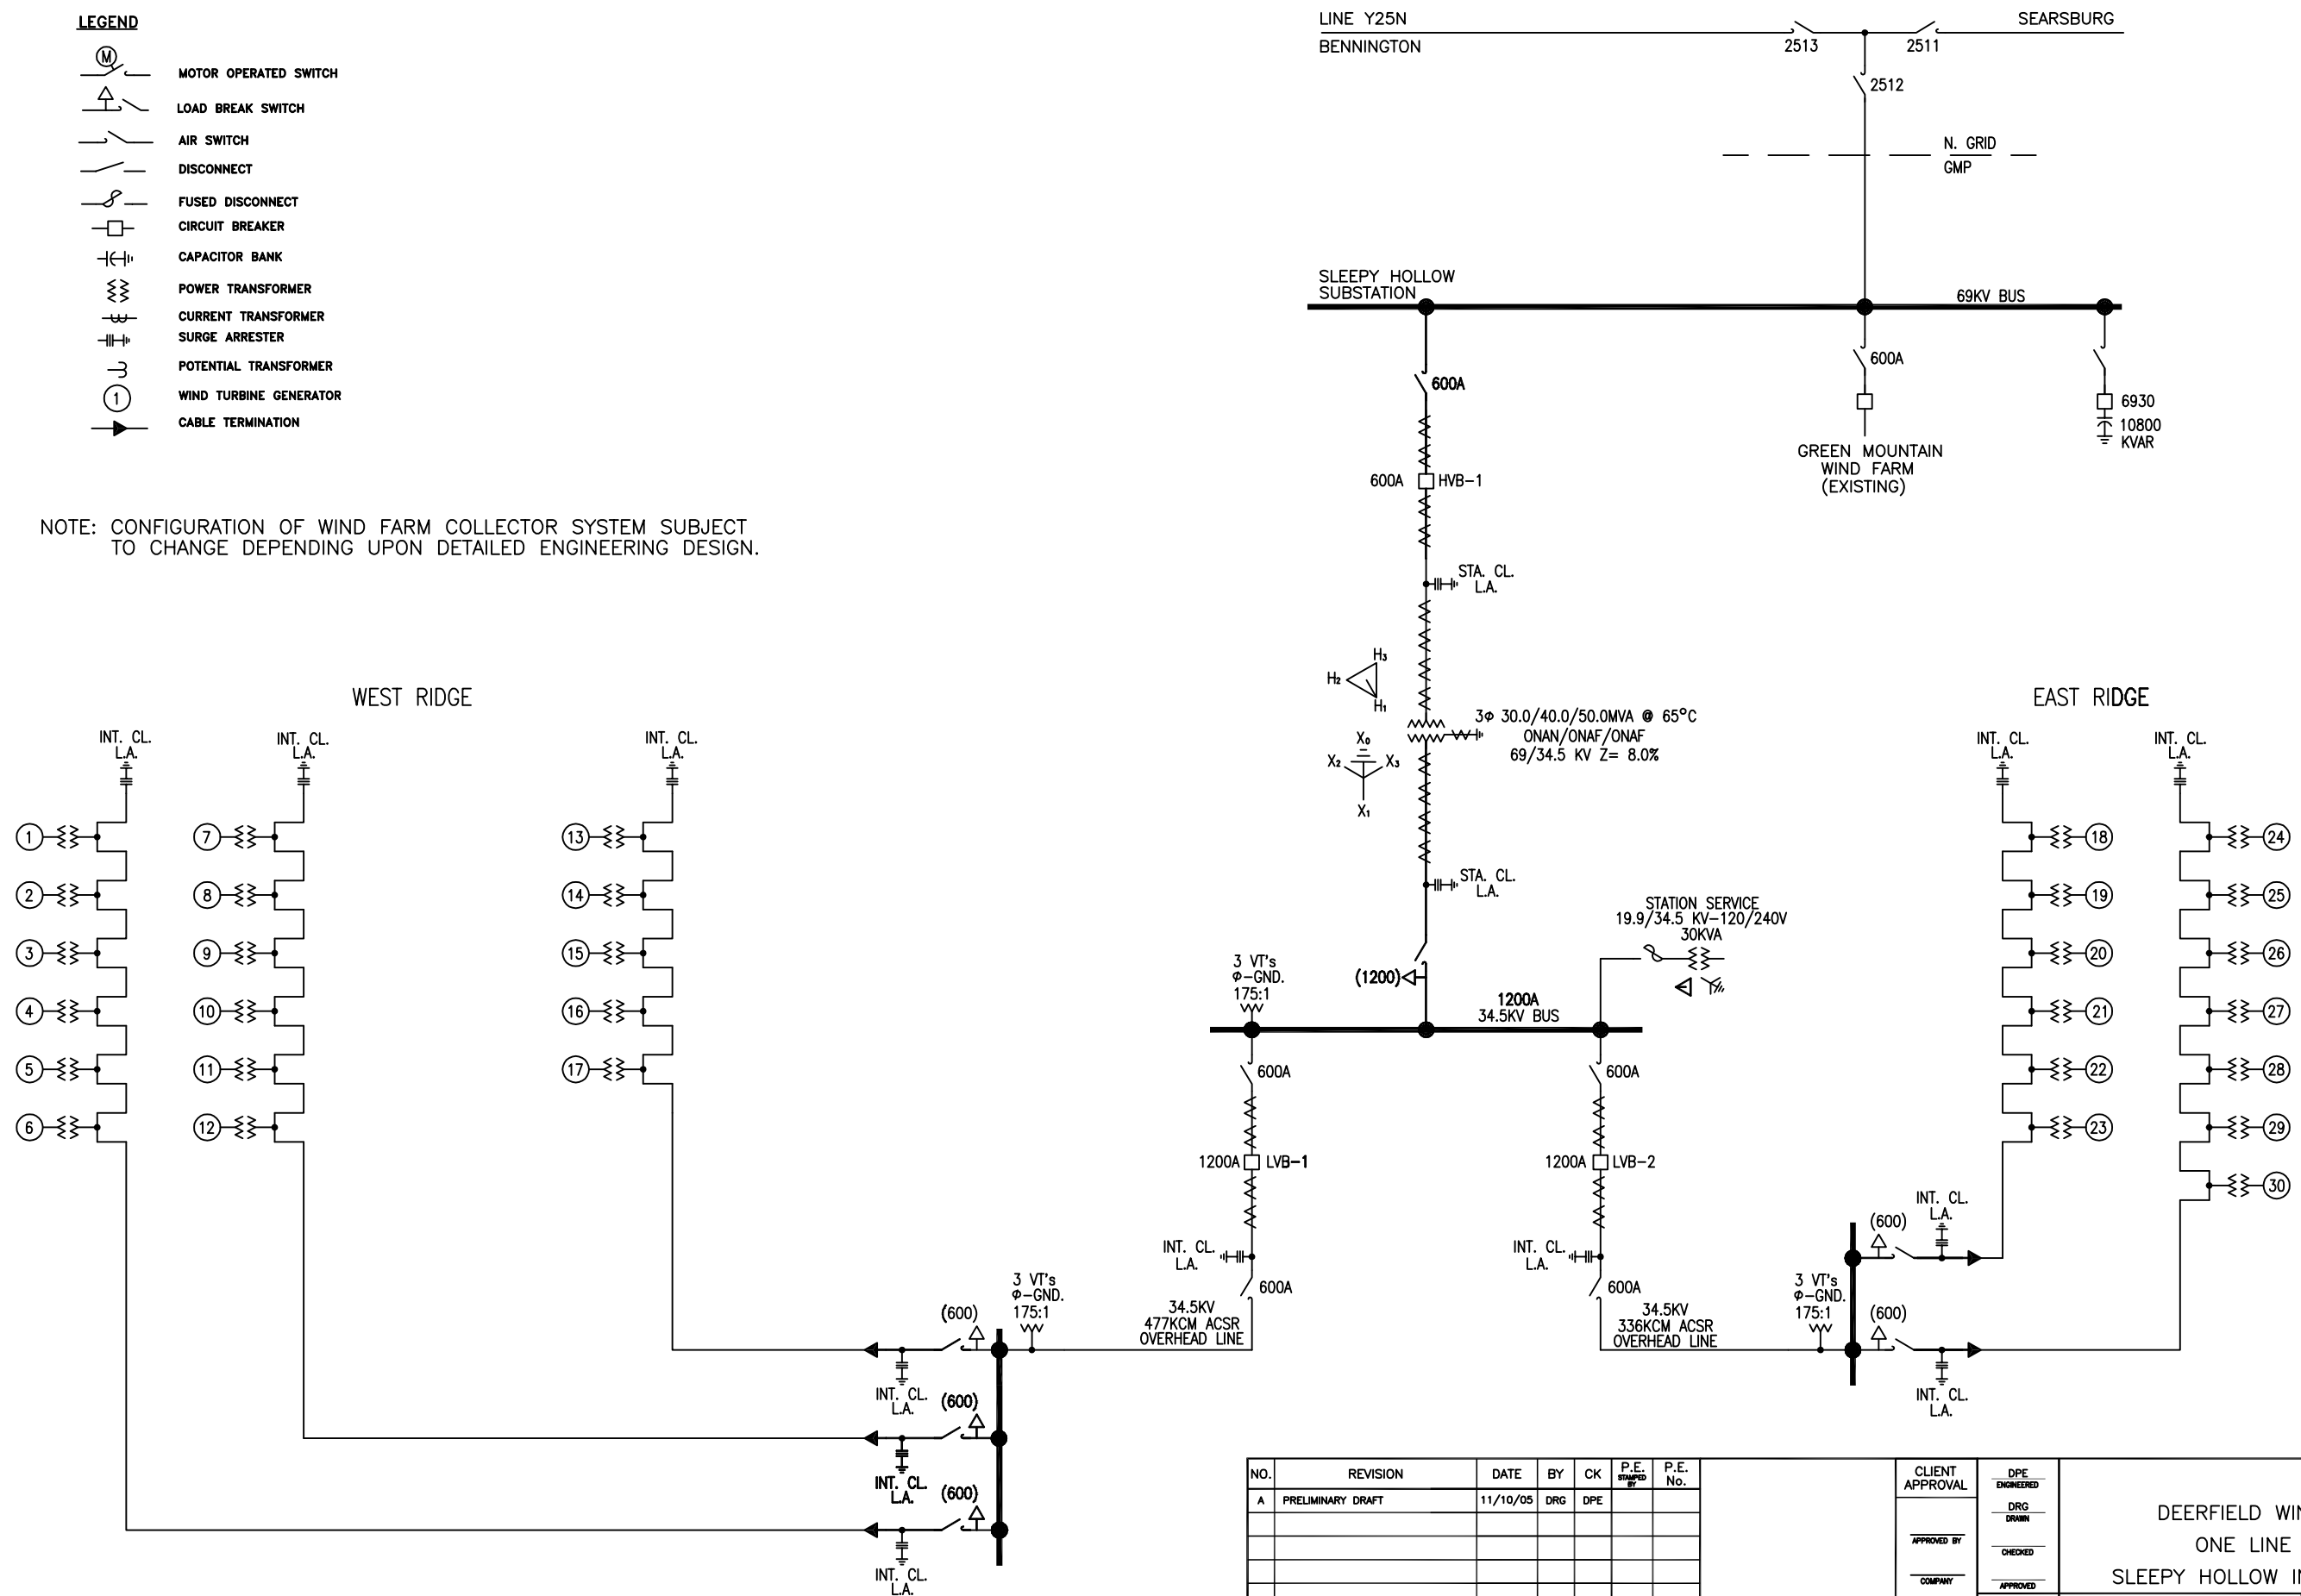NO.	REVISION	DATE	BY	CK	P.E. STAMPED BY	P.E. No.
A	PRELIMINARY DRAFT	11/10/05	DRG	DPE		

CLIENT APPROVAL	DPE ENGINEERED
APPROVED BY	DRG DRAWN
COMPANY	CHECKED
DATE	APPROVED
	REVIEWED

DEERFIELD WIND PROJECT
ONE LINE DIAGRAM
SLEEPY HOLLOW INTERCONNECTION

E-PRO Engineering & Environmental Consulting, LLC
249 Western Avenue
Augusta, Maine 04330
SCALE N.T.S. DATE 11/10/05

11556-E501 REV. A

Engineering & Environmental Consulting, LLC
 249 Western Ave, Augusta, Maine 04330
 PROJECT NO. 11489
 CONTRACT DWG NO. 11489-E500
 THIS DRAWING SHALL BE REVISED ON THE CADD SYSTEM ONLY